



DO NOT SCALE. WORK TO FIGURED DIMENSIONS ONLY.
 ALL EXISTING DIMENSIONS TO BE CHECKED ON SITE.
 DRAWN ON AUTOCAD R2004 AT DEADY GAHAN ARCHITECTS LTD
 LAYERS ON THIS DRAWING COMPLY WITH BS 1192: PART 5

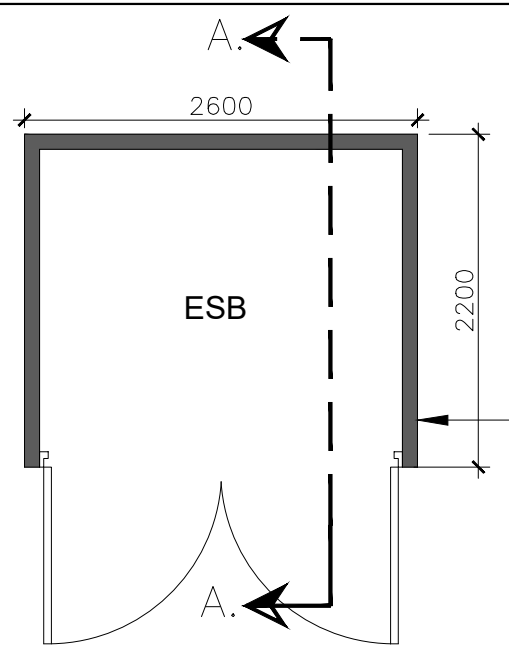

PLAN
 ESB SUBSTATION
 SCALE 1:50 @ A3


Substation is to be located minimum of 5 metres from the nearest house

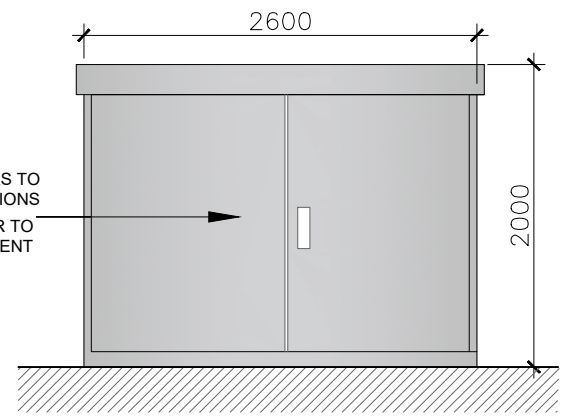


FRONT ELEVATION
 ESB SUBSTATION
 SCALE 1:50 @ A3

METAL DOORS TO ESB SPECIFICATIONS
 MID GREY COLOUR TO MATCH DEVELOPMENT

ESB KIOSK FOUNDATION PLINTH

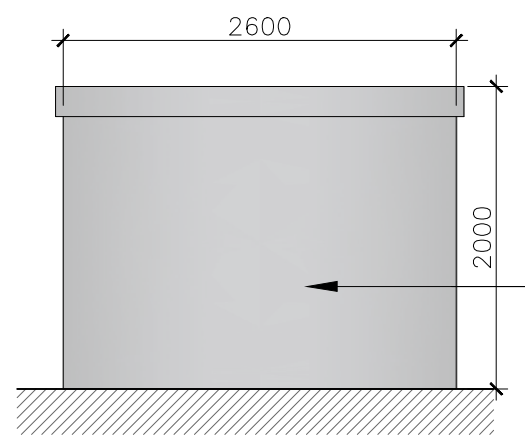


REAR ELEVATION
 ESB SUBSTATION
 SCALE 1:50 @ A3

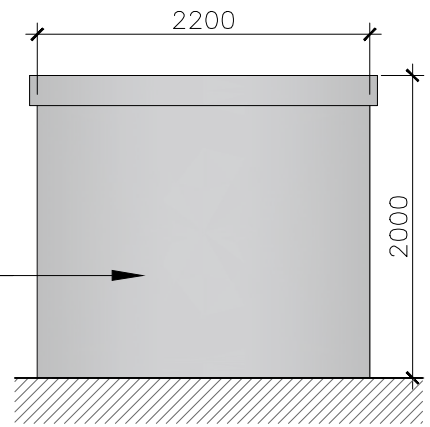


SIDE ELEVATION
 ESB SUBSTATION
 SCALE 1:50 @ A3

METAL WALLS TO ESB SPECIFICATIONS
 MID GREY COLOUR TO MATCH DEVELOPMENT

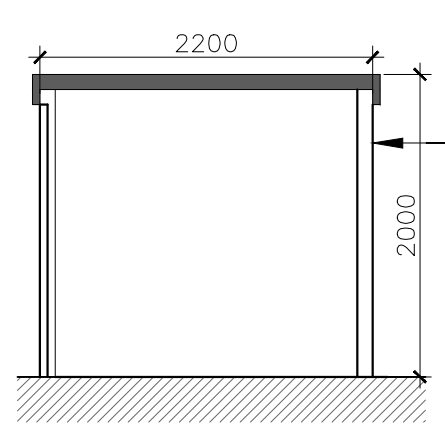


SECTION A-A
 ESB SUBSTATION
 SCALE 1:50 @ A3

METAL WALLS TO ESB SPECIFICATIONS
 MID GREY COLOUR TO MATCH DEVELOPMENT

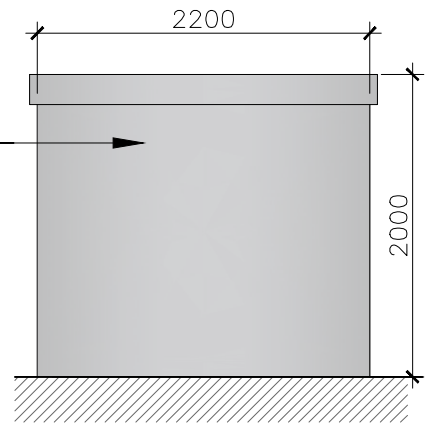

SIDE ELEVATION
 ESB SUBSTATION
 SCALE 1:50 @ A3

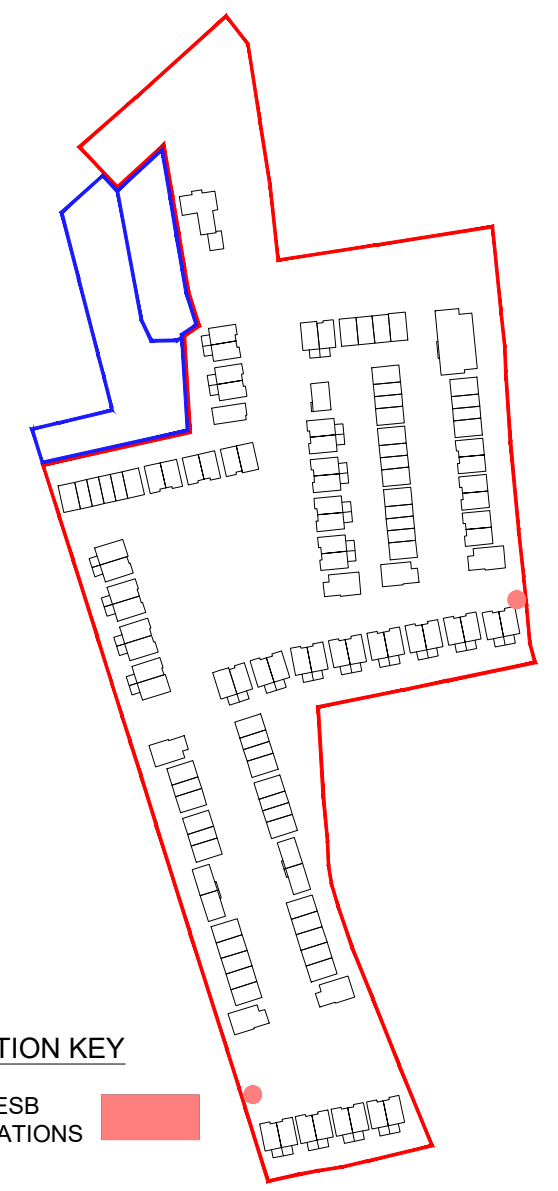

LOCATION KEY
 NTS @ A3
 No. 02 ESB SUBSTATIONS

ESB Substation

GROSS INTERNAL AREA
 4.9 SQ.M.

date	rev	name	chk	note
01.08.25	P1	MP	EJG	ISSUE FOR PLANNING

Project
 PROPOSED RESIDENTIAL DEVELOPMENT
 ON ROSS ROAD, KILLARNEY,
 CO. KERRY.

Drawing title
 PROPOSED ESB SUBSTATIONS
 PLAN, ELEVATIONS AND SECTION AA

Scale	Drawn	Checked	Date
1:50 @A3	MP	EJG	01.08.25
Project No.	Dwg. No.	Revision	
24096	24096/P/016	P1	

Information \ Comments Tender
 Planning Construction

Note
 Please refer to Site Plan (drawing no. 24096/P/003) for orientation.

PROPOSED ESB SUBSTATIONS
 SCALE 1:50 @ A3